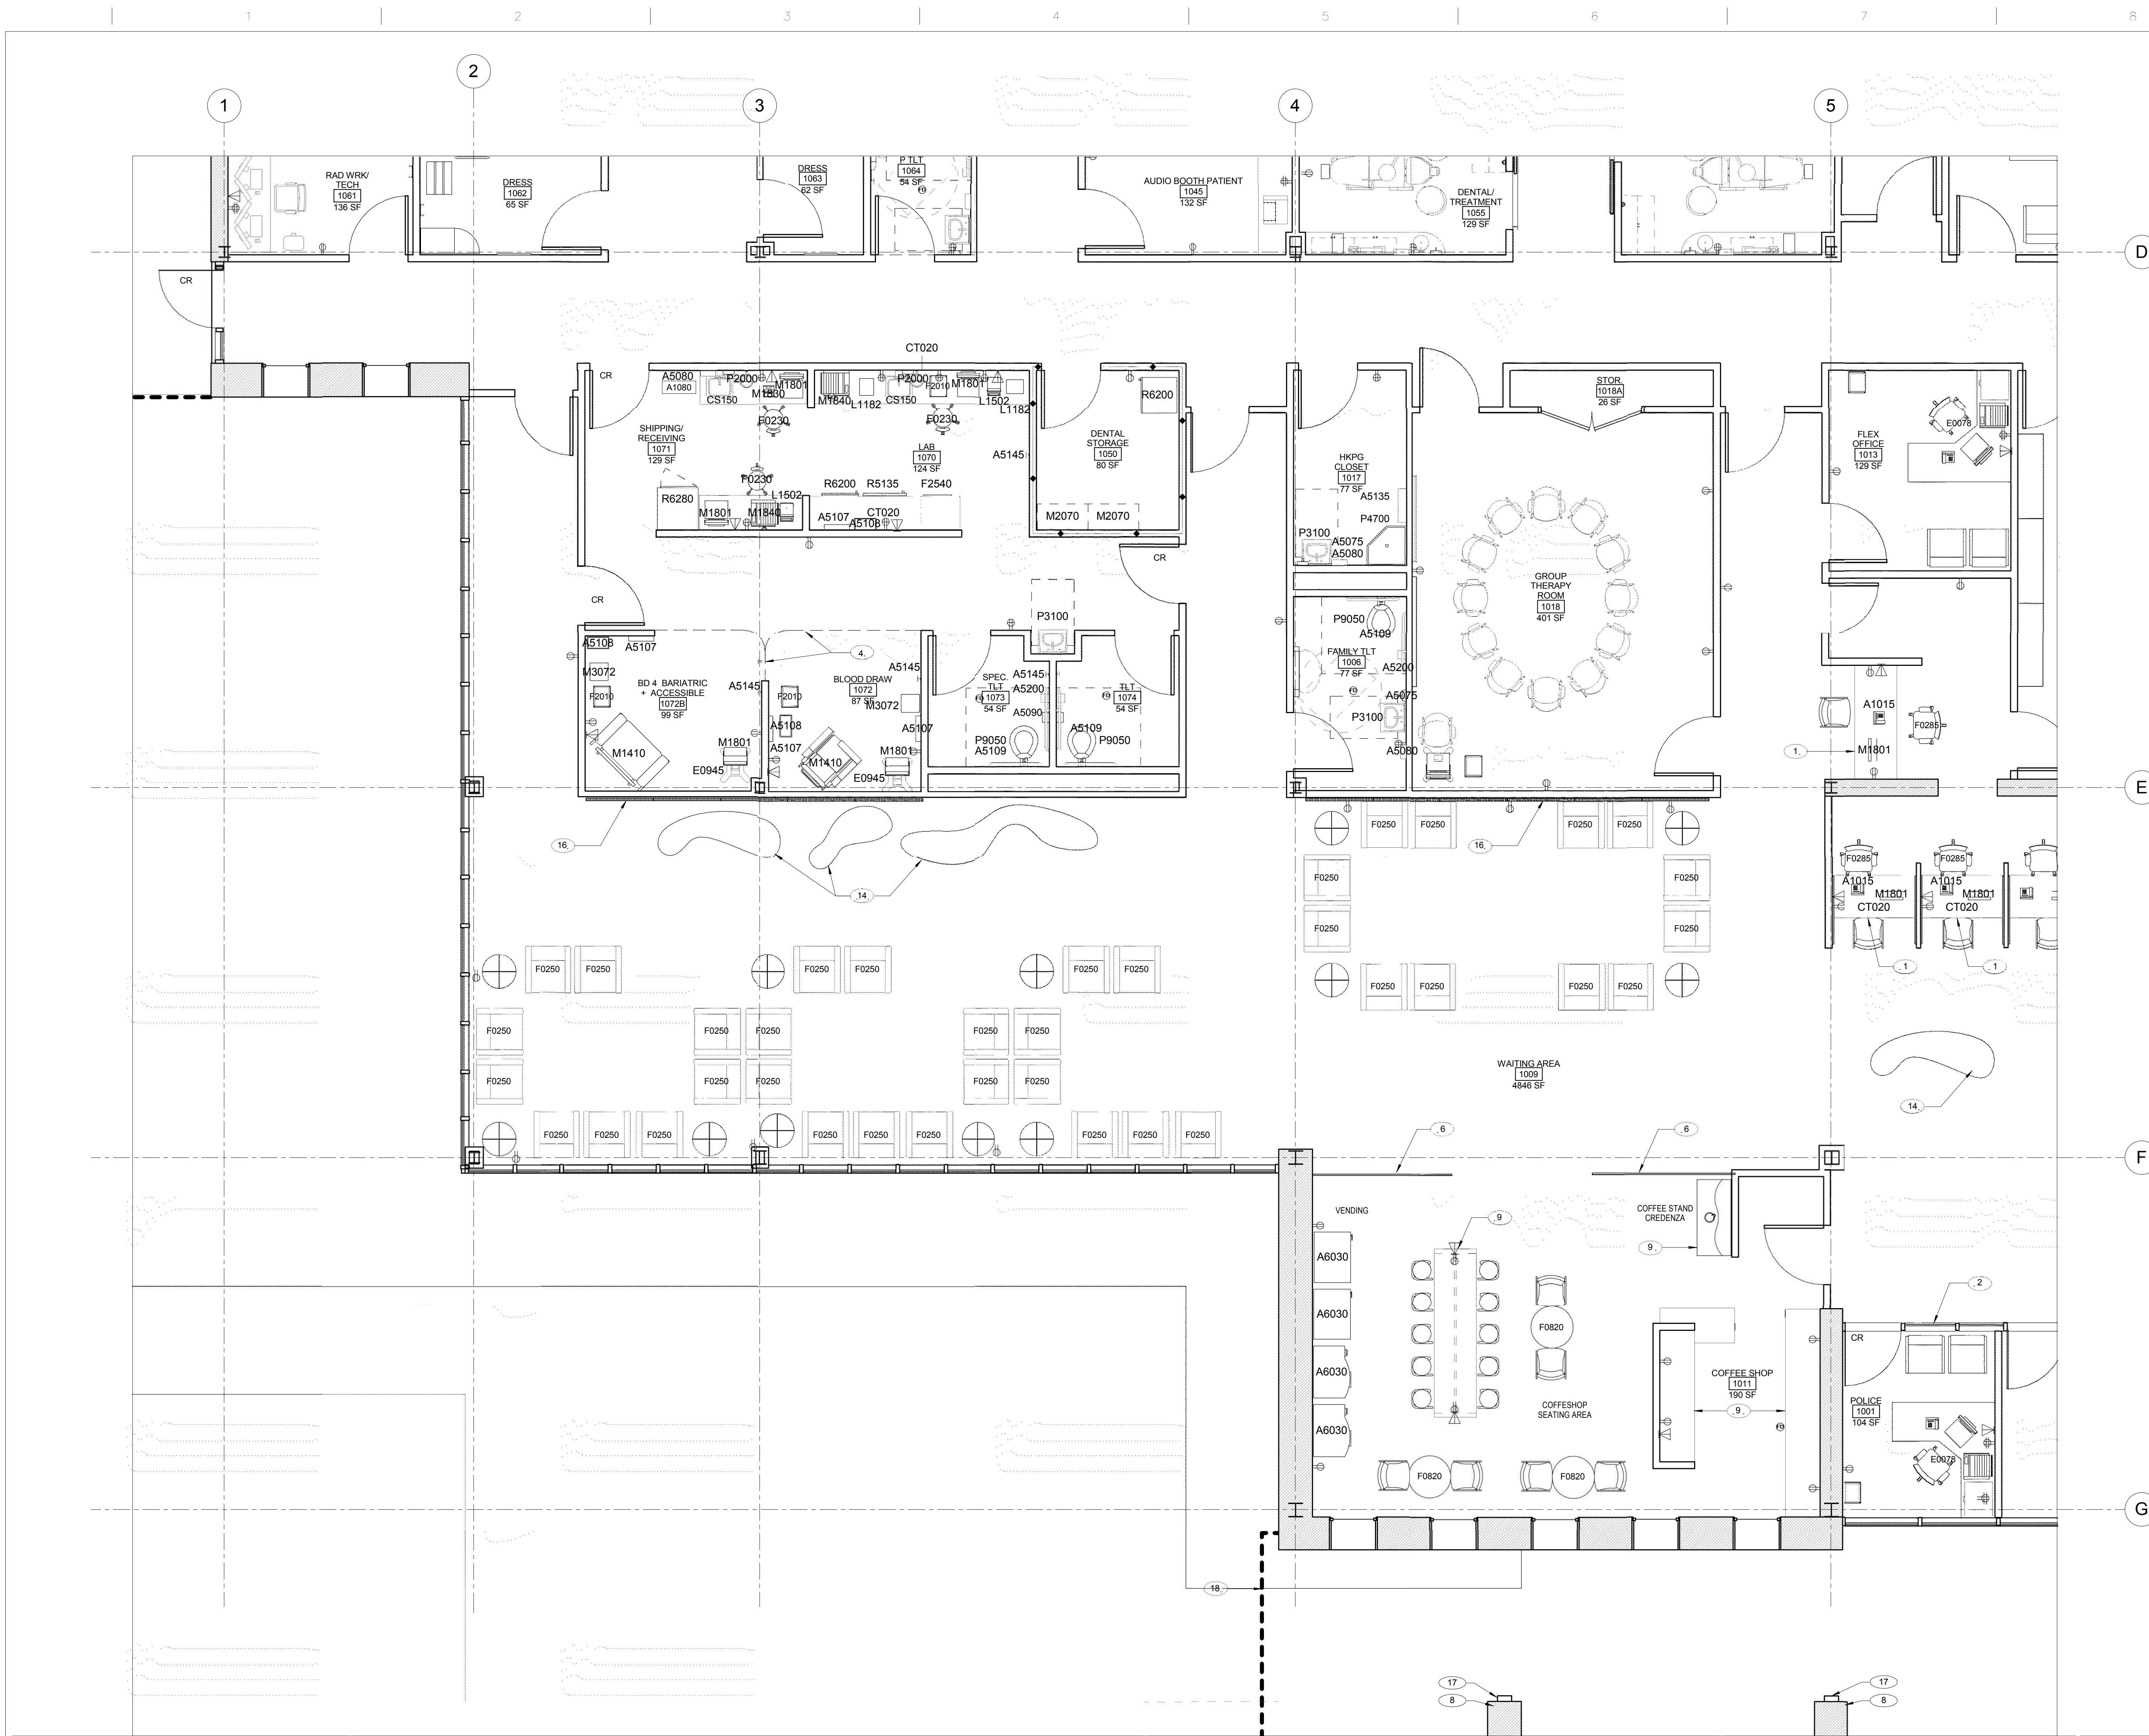


three inches = one foot
one and one half inches = one foot
one inch = one foot
three quarters inch = one foot
one half inch = one foot
three eighths inch = one foot
one quarter inch = one foot
one eighth inch = one foot
one sixteenth inch = one foot



GENERAL NOTES

1. REFERENCE SCHEDULE "E" OF THE SFO PART II FOR ROOM FINISHES AND DOOR INFORMATION.
2. COORDINATE ALL WALL & FLOOR OUTLETS AND DATA/TELECOM PORTS WITH EQUIPMENT & FURNITURE LOCATIONS.
3. ALL CONSTRUCTION MUST COMPLY WITH ALL LOCAL BUILDING CODES.
4. PROVIDE WALL PROTECTION AS OUTLINED IN THE SFO PART I OR PROVIDE WALL PROTECTION AS REQUIRED.
5. PROVIDE FLOOR DRAINS IN ALL TOILET ROOMS.
6. PROVIDE FIRE EXTINGUISHER CABINETS AS REQUIRED BY CODE.
7. COORDINATE ALL BUILDING ENTRIES WITH SITE GRADE.
8. PROVIDE BACKING AND STRUCTURAL SUPPORT FOR ALL CEILING MOUNTED EQUIPMENT, WALL MOUNTED EQUIPMENT AND PASS-THROUGH BOXES.
9. PROVIDE LEAD-LINED OR RF SHIELDING IN PARTITIONS, DOORS, AND BORROW LIGHTS IN ROOMS WITH IMAGING EQUIPMENT PER MANUFACTURER'S RECOMMENDATIONS AND SHIELDING PHYSICIST'S REPORT.

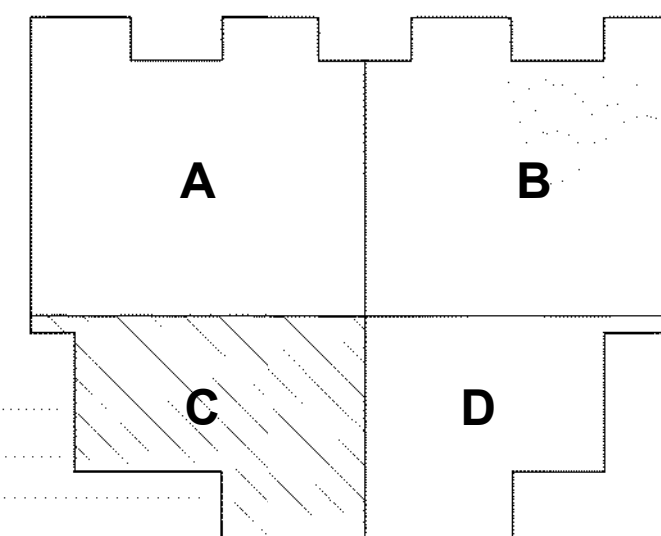
KEY NOTES

1. CUSTOM MILLWORK - REGISTRATION DESK & PRIVACY PANELS
2. ALUMINUM STOREFRONT W/ CLEAR GLASS AND CAPTURED VERTICAL MULLIONS.
3. SYSTEMS FURNITURE.
4. CURTAIN & TRACK @ CEILING ABOVE.
5. CEILING HUNG STAINLESS STEEL TOILET PARTITION.
6. FRAMELESS CLEAR GLASS PARTITION.
7. WINDOW COVERING, ROLLER SHADES WITH BLACK OUT. PROVIDE AT TELEMED 1127 AND TELEMED 1129 EXTERIOR WINDOWS ONLY.
8. ENTRANCE CANOPY SUPPORT.
9. BUILT-IN CUSTOM CASEWORK.
10. BABY CHANGE STATION.
11. LINE OF CLERESTORY WINDOW ABOVE.
12. ALUMINUM STOREFRONT W/ CLEAR BUTT GLAZING. PROVIDE GLASS WITH FRIT PATTERN.
13. LOCKERS.
14. FREE-FORM BENCH
15. FREE-FORM BENCH SUITABLE FOR CHILDREN
16. ACOUSTICAL PERFORATED PANELS.
17. 4"x12" PREFINISHED ALUMINUM DOWN-SPOUT ANCHORED TO ENTRANCE CANOPY SUPPORT. DOWNSPOUT TO CONNECT TO CIVIL DRAIN LINE.
18. LINE OF CANOPY ABOVE

LEGEND

- 2 HR FIRE RATED FIRE-BARRIER
- 1 HR FIRE RATED FIRE-BARRIER
- SHIELDED WALL
- FLOOR DRAIN
- ELECT. DUPLEX
- ELECT. DUPLEX, G.F.I.
- ELECT. QUADRUPLUX
- PHONE/DATA OUTLET
- CARD READER
- TYPICAL ROOM LAYOUT OF PLAN

KEY PLAN



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Office of
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and Facilities
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Department of
Veterans Affairs

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Drawing Title

ENLARGED FLOOR PLANS - LEVEL 01 -
SECTOR C

1/4" = 1'-0"

Approved: Project Director

Project Title

VA OUTPATIENT CLINIC

Building Number

CANNON DESIGN PROJECT NO. 3850.06

Location

JOHNSON COUNTY, KS

Date

DEC 18, 2015

Checked

SDM

Drawn

JH

Project Number

CANNON DESIGN PROJECT NO. 3850.06

Building Number

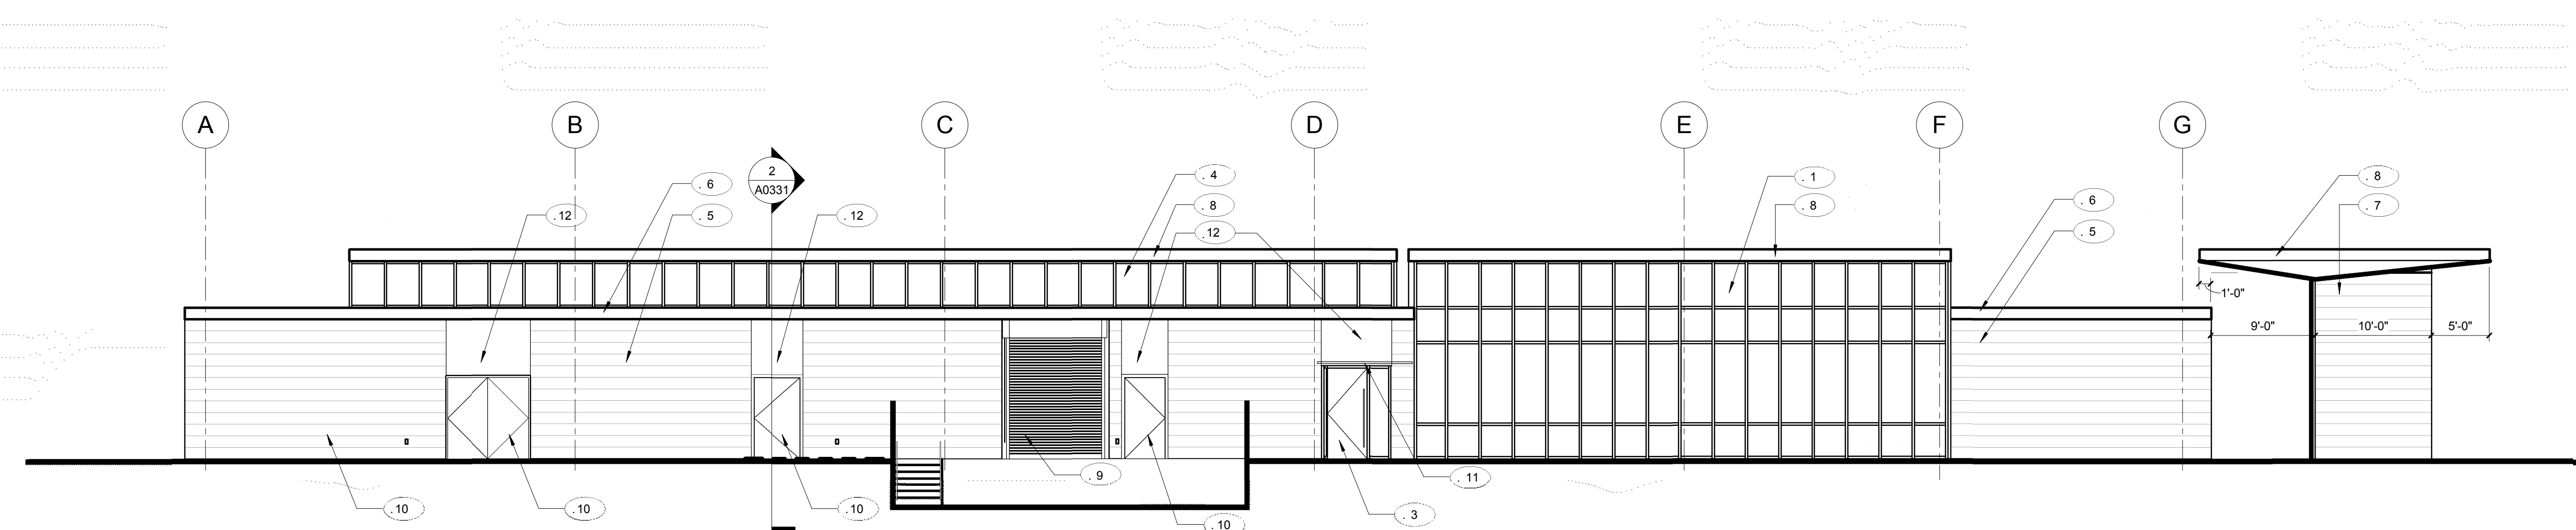
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Drawing Number

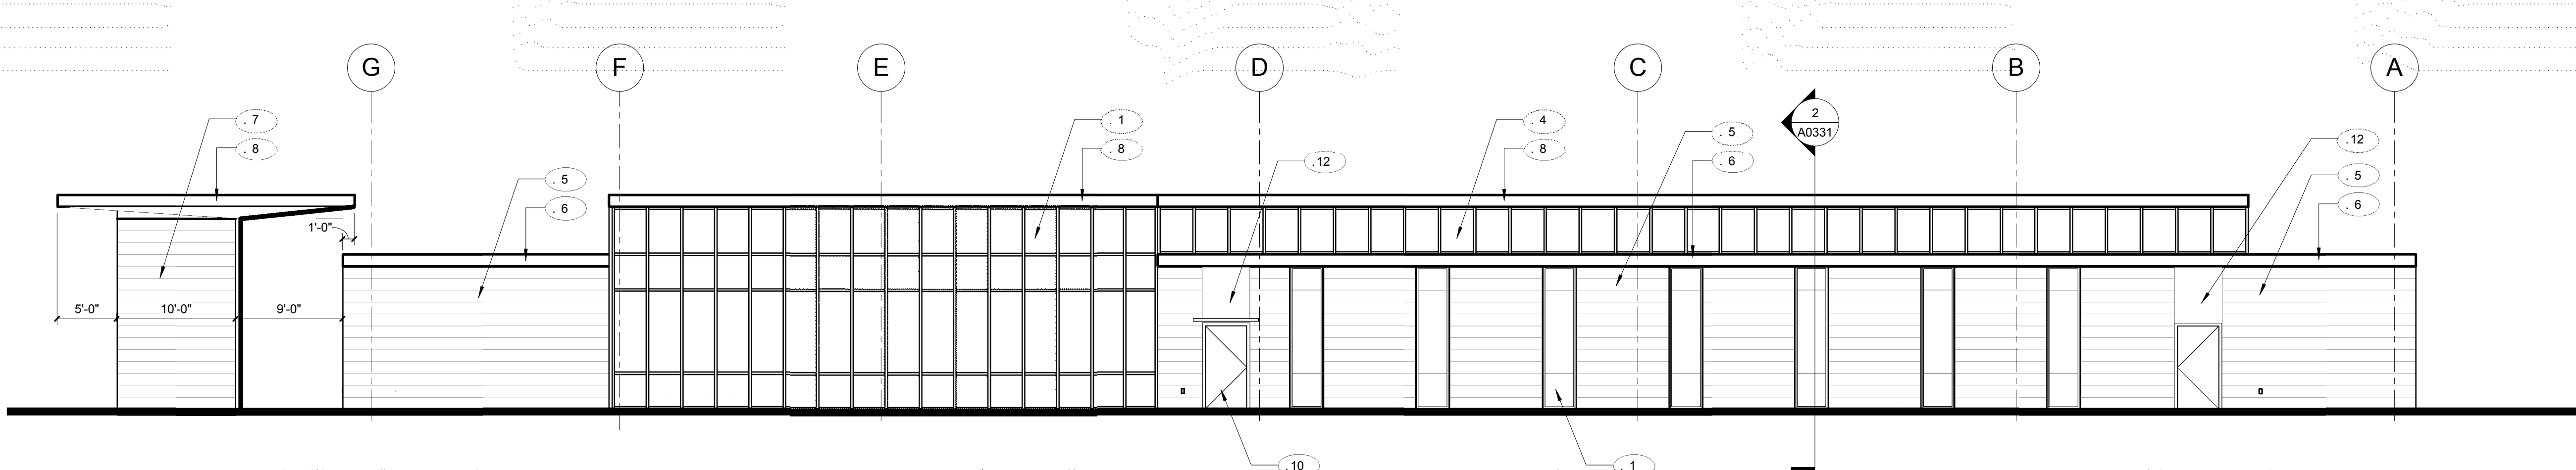
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DWG 7 OF 13

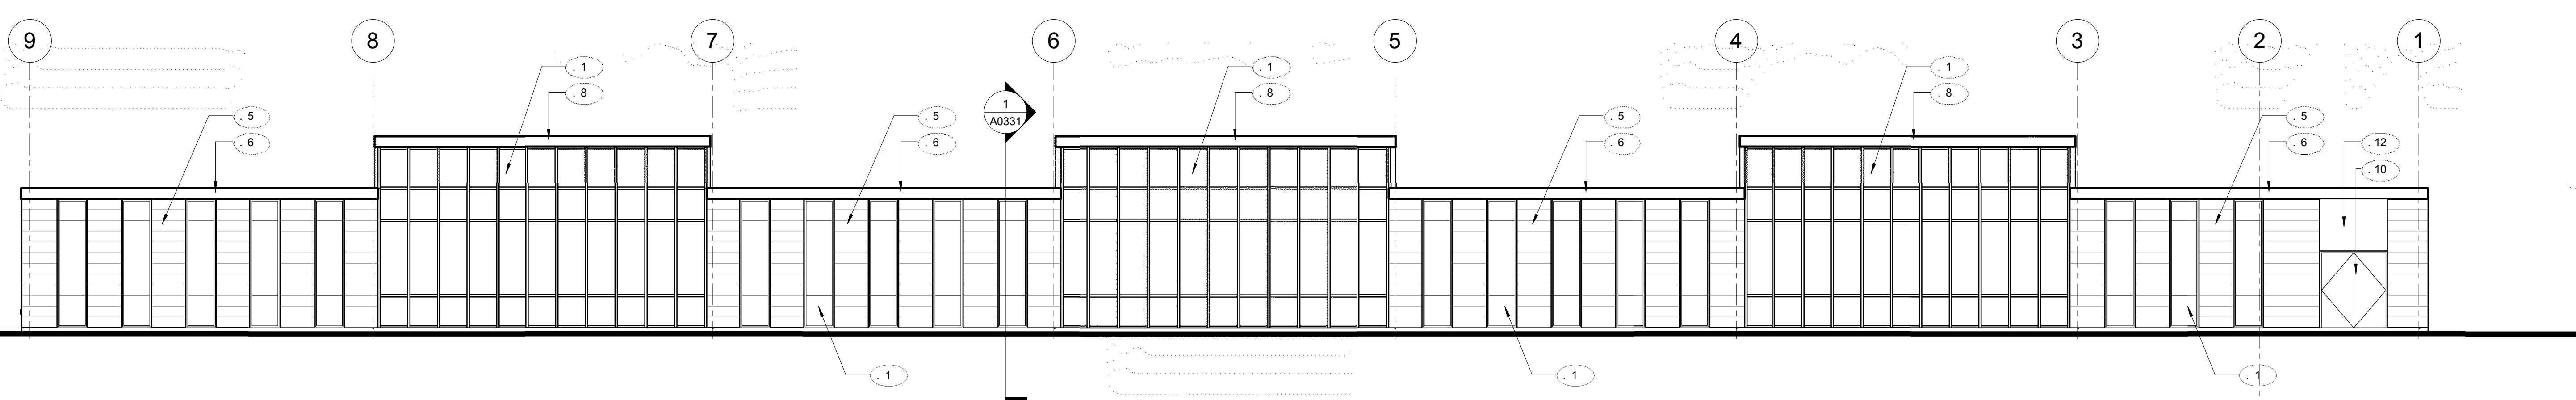
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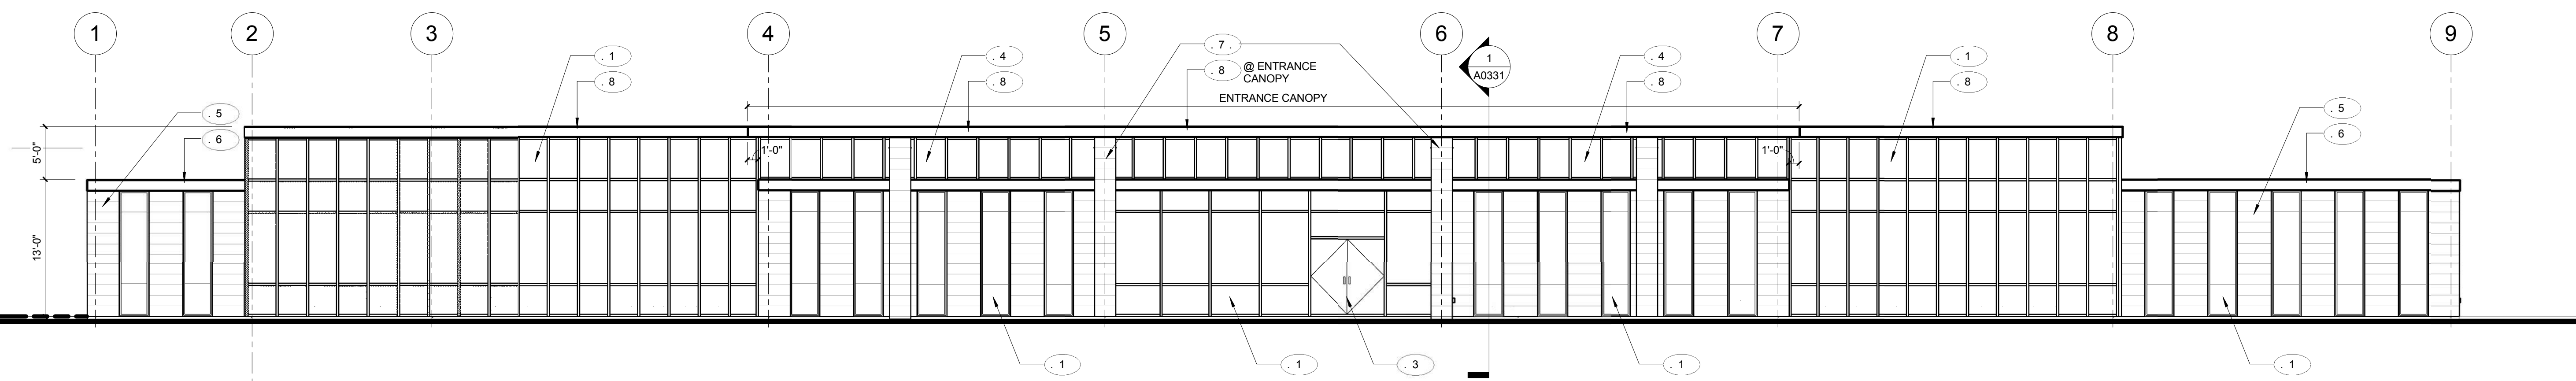
SIDE ELEVATION



SIDE ELEVATION



REAR ELEVATION



ENTRY ELEVATION

GENERAL NOTES

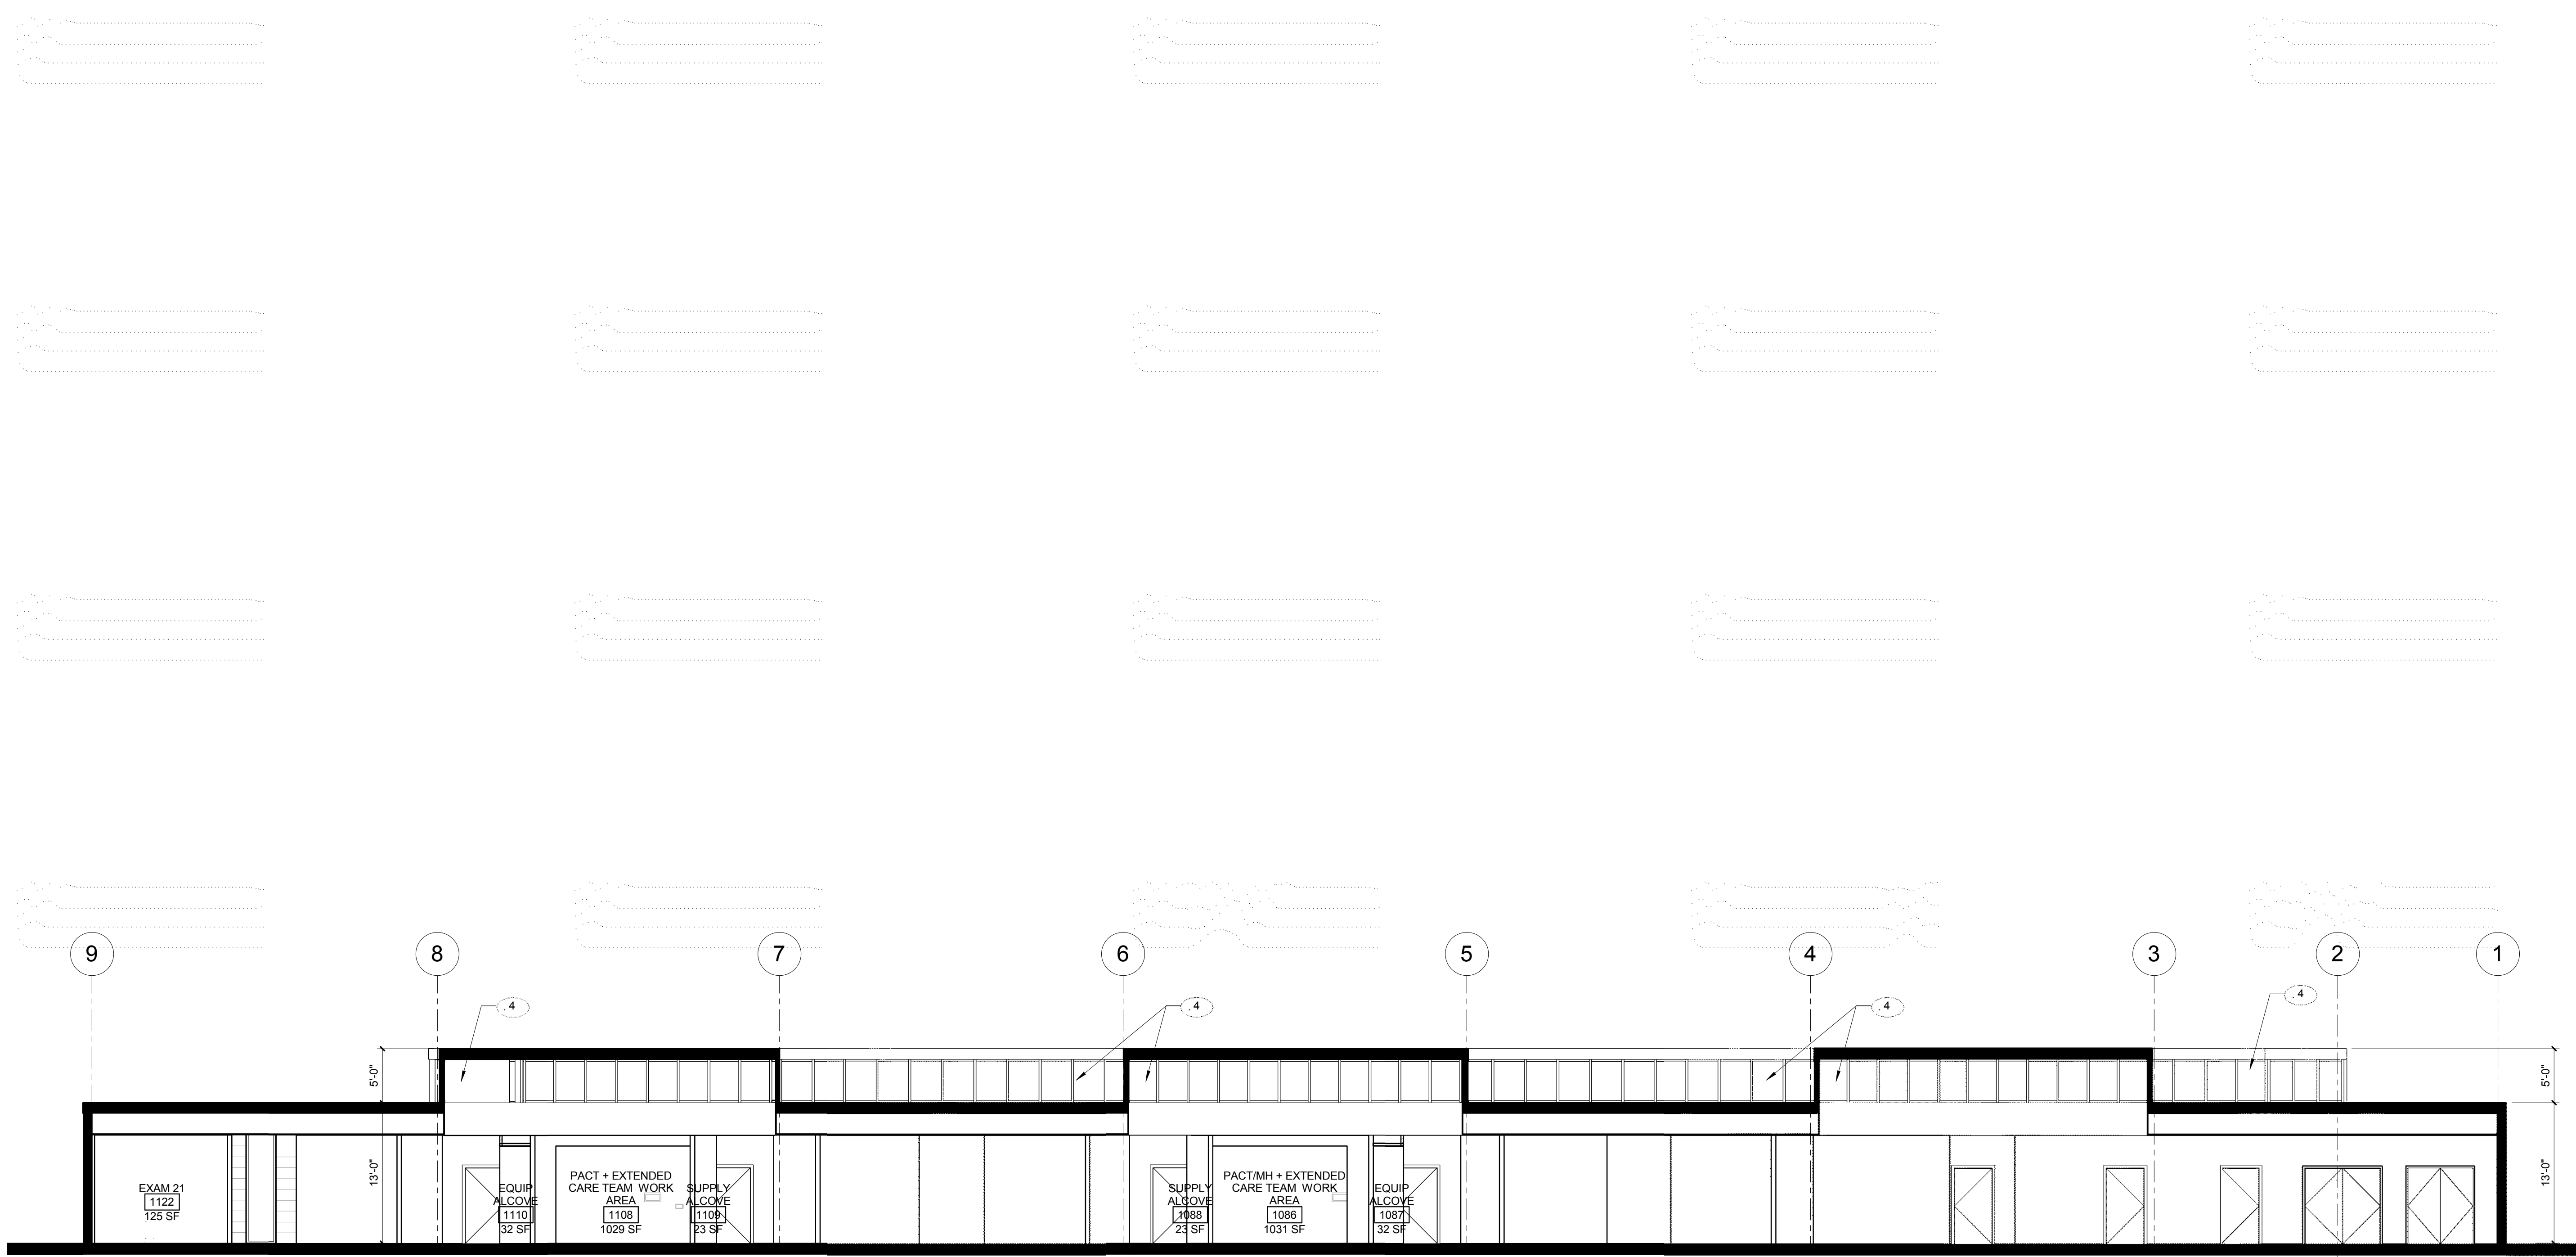
1. COORDINATE ALL BUILDING ENTRIES WITH SITE GRADE.
2. COORDINATE ALL WINDOW MULLIONS W/ FINALIZED WALL LOCATIONS AT CENTERLINE OF WALL TO CENTERLINE OF MULLION.
3. EXTERIOR ENCLOSURE MATERIALS & SYSTEMS SHALL MEET VA EXTERIOR REQUIREMENTS. REFERENCE STANDARDS IN THE SFO OR THROUGH THE TECHNICAL INFORMATION LIBRARY (TIL).
4. COORDINATE UTILITIES WITH MECHANICAL, PLUMBING AND ELECTRICAL ROOMS.
5. TO MEET THE DAYLIGHTING AND ENERGY GOALS FOR THE PROJECT, EXTERIOR SUN CONTROL DEVICES MAY BE REQUIRED AT WINDOW OPENINGS DEPENDING ON THE ORIENTATION OF THE BUILDING. THE DESIGN OF THESE DEVICES SHALL BE INTEGRATED WITH THE DESIGN OF WINDOW SYSTEMS AND MEET ALL PHYSICAL SECURITY DESIGN REQUIREMENTS.
6. ALL EXTERIOR GLASS WINDOWS SHALL BE CLEAR, LOW E, INSULATED GLAZING UNITS U.I.O.

KEYED ELEVATION AND SECTION NOTES

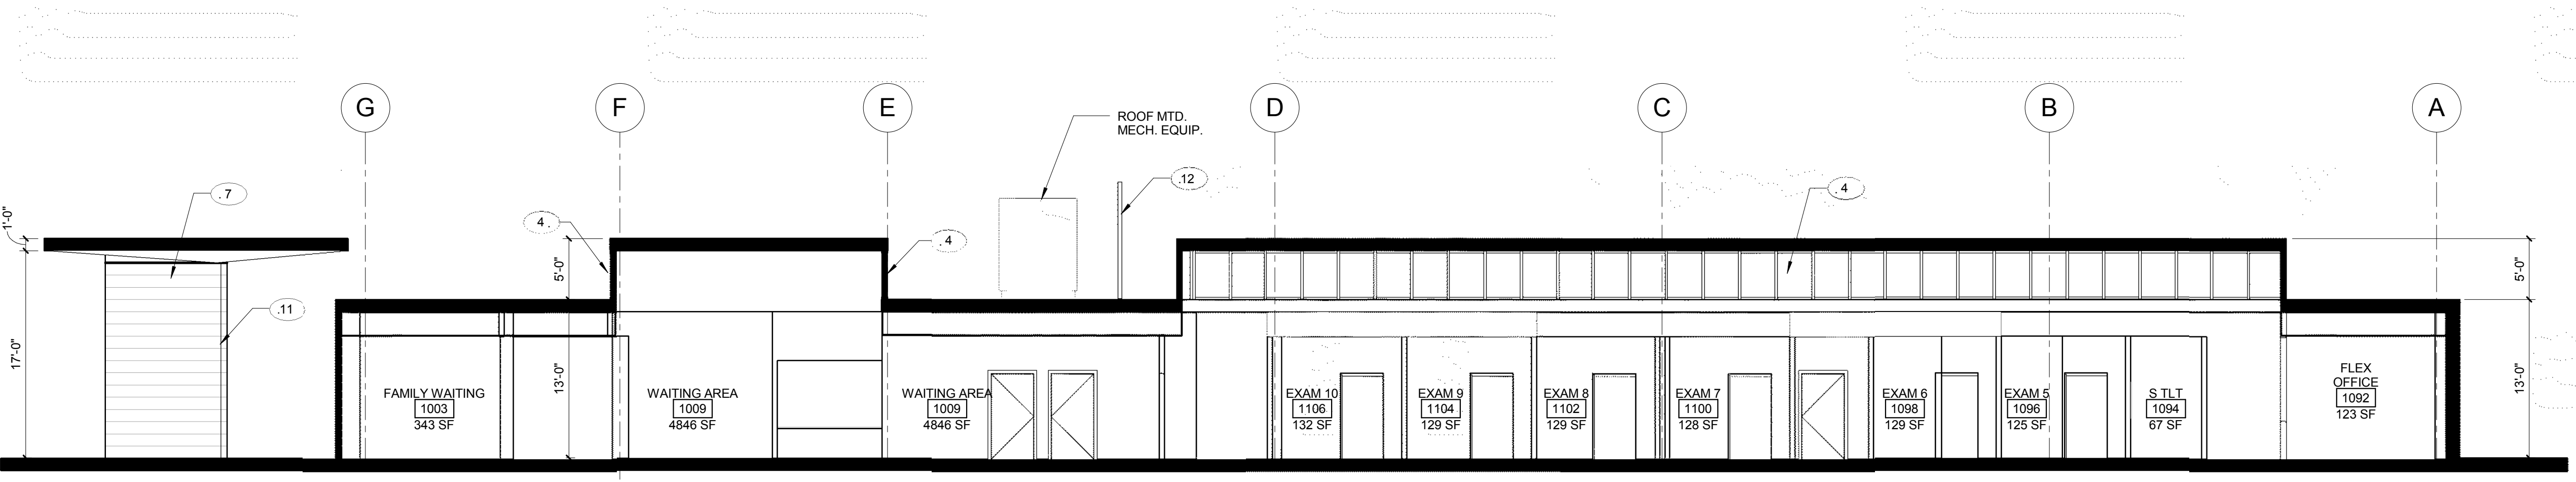
- 1 PREFINISHED ALUMINUM CURTAINWALL SYSTEM WITH CLEAR, LOW-E INSULATED GLAZING UNITS. GLAZING W/ VERTICAL CAPTURED MULLIONS & HORIZONTAL STRUCTURALLY GLAZED JOINTS (WHERE OCCURS).
- 2 PREFINISHED ALUMINUM STOREFRONT SYSTEM WITH CLEAR, LOW-E INSULATED GLAZING UNITS.
- 3 PREFINISHED ALUMINUM STOREFRONT ENTRANCE DOORS WITH CLEAR, LOW-E INSULATED GLAZING UNITS.
- 4 PREFINISHED ALUMINUM STOREFRONT CLERESTORY WITH CLEAR, LOW-E INSULATED GLAZING UNITS.
- 5 4" THICK REGIONAL LIMESTONE (COLOR #1) OV/ STUD WALL BACKER.
- 6 REGIONAL LIMESTONE (COLOR #2) COPING.
- 7 REGIONAL LIMESTONE ENTRANCE CANOPY COLUMNS (COLOR #1).
- 8 COMPOSITE ALUMINUM FASCIA/ COPING.
- 9 PREFINISHED COILING OVERHEAD DOOR.
- 10 PAINTED INSULATED H.M. DOOR & FRAME.
- 11 ENTRANCE CANOPY.
- 12 COMPOSITE ALUMINUM PANEL SYSTEM.

<div>Revisions:</div> <div>Date</div>		<div>CONSULTANT:</div> <div>The LA Group</div> <div>40 Long Alley</div> <div>Saratoga Springs, NY 12866</div> <div>T: 518.587.8100</div> <div>www.thelagroup.com</div>	<div>ARCHITECT/ENGINEERS:</div> <div>CANNONDESIGN</div> <div>1100 Clark Avenue</div> <div>St. Louis, Missouri 63102</div> <div>T: 314.241.6250</div> <div>F: 314.241.2570</div> <div>© CannonDesign 2015</div> <div>All rights reserved. No part of this document may be reproduced or utilized in any form, without prior written authorization by the Cannon Corporation</div>	<div>Drawing Title</div> <div>EXTERIOR ELEVATIONS</div> <div>1/8" = 1'-0"</div> <div>Approved: Project Director</div>	<div>Project Title</div> <div>VA OUTPATIENT CLINIC</div> <div>Location</div> <div>JOHNSON COUNTY, KS</div> <div>Date</div> <div>DEC 18, 2015</div> <div>Checked</div> <div>SDM</div> <div>Drawn</div> <div>HRS</div>	<div>Project Number</div> <div>CANNON DESIGN PROJECT NO. 3850.06</div> <div>Building Number</div> <div></div> <div>Drawing Number</div> <div>A0301</div> <div>DWG 10 OF 13</div>	<div>NOT FOR CONSTRUCTION</div> <div>Office of Construction and Facilities Management</div> <div>Department of Veterans Affairs</div>
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BUILDING SECTION 2



BUILDING SECTION 1

GENERAL NOTES

1. COORDINATE ALL BUILDING ENTRIES WITH SITE GRADE.
2. COORDINATE ALL WINDOW MULLIONS W/ FINALIZED WALL LOCATIONS AT CENTERLINE OF WALL TO CENTERLINE OF MULLION.
3. COORDINATE EXTERIOR MATERIALS TO MEET VA EXTERIOR REQUIREMENTS. REFERENCE STANDARDS IN THE SFO OR THROUGH THE TECHNICAL INFORMATION LIBRARY (TIL).
4. COORDINATE UTILITIES WITH MECHANICAL, PLUMBING AND ELECTRICAL ROOMS.

KEYED ELEVATION AND SECTION NOTES

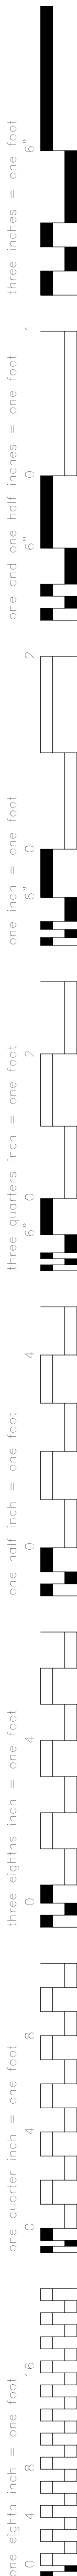
1. PAINTED ALUMINUM CURTAINWALL SYSTEM WITH CLEAR, LOW-E INSULATED GLAZING UNITS. GLAZING W/VERTICAL CAPTURED MULLIONS & HORIZONTAL STRUCTURALLY GLAZED JOINTS (WHERE OCCURS)
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3. PAINTED ALUMINUM STOREFRONT ENTRANCE DOORS WITH CLEAR, LOW-E INSULATED GLAZING UNITS
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7. REGIONAL LIMESTONE ENTRANCE CANOPY COLUMNS (COLOR #1)
8. COMPOSITE ALUMINUM FASCIA/ COPING
9. PAINTED ROLL-UP OVERHEAD DOOR
10. PAINTED H.M. DOOR & FRAME
11. ENTRANCE CANOPY DOWNSPOUT
12. MECHANICAL EQUIPMENT SCREEN

CONSULTANT: The LA Group 40 Long Alley Saratoga Springs, NY 12866 T: 518.587.8100 www.thelagroup.com		ARCHITECT/ENGINEERS: CANNONDESIGN 1100 Clark Avenue St. Louis, Missouri 63102 T: 314.241.6250 F: 314.241.2570 <small>© CannonDesign 2015 All rights reserved. No part of this document may be reproduced or utilized in any form, without prior written authorization by the Cannon Corporation</small>		Drawing Title BUILDING SECTIONS 1/8" = 1'-0"		Project Title VA OUTPATIENT CLINIC		Project Number CANNON DESIGN PROJECT NO. 3850.06																					
Revisions: <table><tr><td> </td><td> </td></tr><tr><td> </td><td> </td></tr><tr><td> </td><td> </td></tr><tr><td> </td><td> </td></tr><tr><td> </td><td> </td></tr><tr><td> </td><td> </td></tr><tr><td> </td><td> </td></tr><tr><td> </td><td> </td></tr><tr><td> </td><td> </td></tr><tr><td> </td><td> </td></tr></table>																								Approved: Project Director		Location JOHNSON COUNTY, KS		Drawing Number A0331 DWG 11 OF 13	
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
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Office of
Construction
and Facilities
Management

Department of
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		CONSULTANT:				ARCHITECT/ENGINEERS:		Drawing Title INTERIOR CONCEPTUAL RENDERINGS		Project Title VA OUTPATIENT CLINIC		Project Number <small>CANNON DESIGN PROJECT NO. 3850-06</small>		<div>Office of Construction and Facilities Management</div> <div> Department of Veterans Affairs</div>	
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		40 Long Alley Saratoga Springs, NY 12866 T: 518.567.8100 www.thelagroup.com				1100 Clark Avenue St. Louis, Missouri 63102 T: 314.241.6250 F: 314.241.2570		Approved: Project Director		Location JOHNSON COUNTY, KS		Drawing Number A0402			
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												DWG 13 OF 13			